

STATE OF LOUISIANA  
DEPARTMENT OF TRANSPORTATION AND DEVELOPMENT


PLANS OF PROPOSED STATE HIGHWAY

FEDERAL PROJECT H001234

STATE PROJECT H.001234

LA 44: INTERSECTION IMPROVEMENT @ LA 934

ASCENSION PARISH

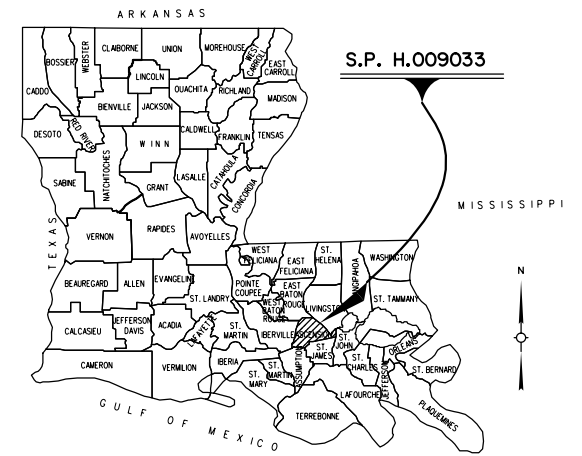

VICINITY MAP

INDEX TO SHEETS

SHEET NO.	DESCRIPTION
1	TITLE SHEET AND LAYOUT MAP
2 - 2a	TYPICAL SECTIONS AND DETAILS
3 -	SUMMARY SHEETS
4 - 13	PLAN AND PROFILE SHEETS
14-23	DRAINAGE PLAN & PROFILE SHEETS
24	EXISTING DRAINAGE MAP
25 - 26	DESIGN DRAINAGE MAP
27 - 30	SUGGESTED SEQUENCE OF CONSTRUCTION AND MINIMUM CONSTRUCTION SIGNING

BRIDGE PLANS

101 -

STANDARD PLANS REV. DATE

201 -

CROSS SECTIONS

401 - 418 CROSS SECTION SHEETS

TOTAL SHEETS =

LA 44 TRAFFIC DATA  
2018 A.D.T. = 20,300  
2038 A.D.T. = 26,900  
D = 55%  
K = 10%  
T = 11%

DESIGN SPEED = 55 M.P.H.

LA 934 TRAFFIC DATA  
2018 A.D.T. = 6,300  
2038 A.D.T. = 9,900  
D = 55%  
K = 10%  
T = 11%

DESIGN SPEED = 45 M.P.H.  
ROADWAY CLASS = URBAN ARTERIAL

TYPE OF CONSTRUCTION


INTERSECTION IMPROVEMENT, EARTHWORK, GRADING, BASE COURSE, SUBSURFACE DRAINAGE, P.C.C. PAVEMENT, ASPHALTIC CONCRETE, PAVEMENT WIDENING, CONCRETE CURB AND TRAFFIC SIGNALIZATION.

BEGIN PROJECT BLACK BAYOU EXT. C.S. 000-03 LOG MILE N/A STA. 40+50.00

BRIDGE SITE: 60.00' STA. 127+93.20 TO STA. 128+53.20 CONCRETE SLAB

END PROJECT LA 44 C.S. 265-02 LOG MILE 1.534 STA. 134+00.00

END PROJECT LA 934 C.S. 803-12 LOG MILE 0.152 STA. 58+00.00

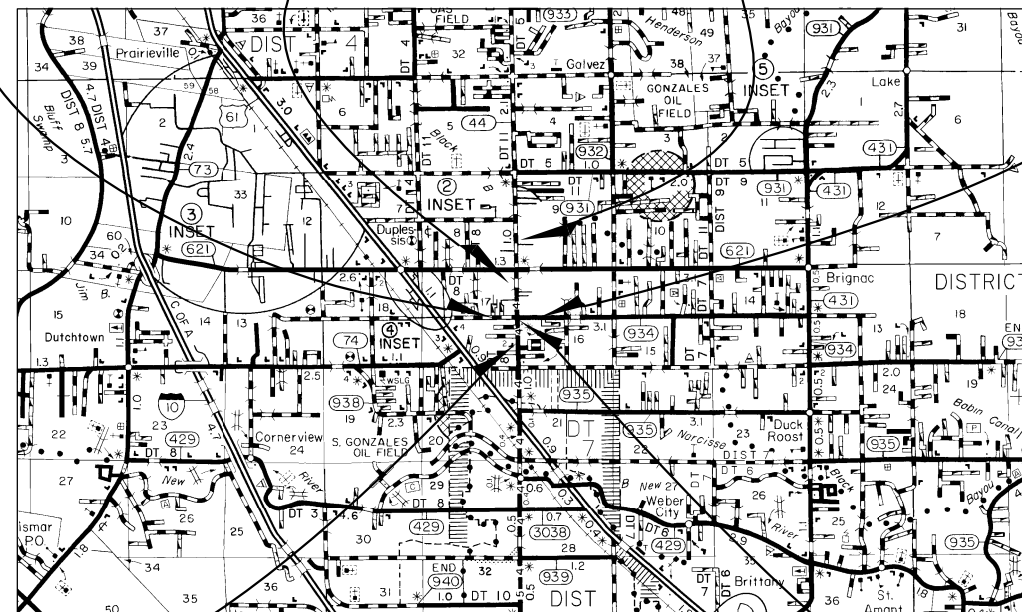

PRELIMINARY EARTHWORK

EXCAVATION 6900 CU. YDS.  
EMBANKMENT 3100 CU. YDS.

LAYOUT MAP

SCALE: 1 INCH = 1 MILE



STANDARD SPECIFICATIONS

THE 2016 EDITION OF THE LOUISIANA DOTD STANDARD SPECIFICATIONS FOR ROADS AND BRIDGES, AS AMENDED BY THE PROJECT SPECIFICATIONS, SHALL GOVERN.

SCALES

PLAN: 1" = 20'  
PROFILE HORIZ: 1" = 20'  
PROFILE VERT: 1" = 4'

DATE	REVISION	DATE	RECOMMENDED	DATE	APPROVED

SCHEDULE OF REVISIONS

APPROVED

DOTD CHIEF ENGINEER

DATE

END PROJECT BLACK BAYOU EXT. BEGIN PROJECT LA 934 C.S. 803-12 LOG MILE 0.000 STA. 50+00.00

LENGTH AND LOCATION OF WORK

CONTROL SECTION	STATION		LOGMILE		ALGEBRAIC SUM OF ALL EQUATIONS FEET	GROSS LENGTH FEET	EXCEPTION FEET	BRIDGE LENGTH		ROADWAY LENGTH	
	BEGIN	END	BEGIN	END				FEET	MILES	FEET	MILES
265-02	97+15.00	134+00.00	0.836	1.593		3685.00		60.00	0.011	3625.00	0.686
803-12	50+00.00	58+00.00	0.000	0.152		800.00				800.00	0.152
000-03	40+50.00	50+00.00	N/A	N/A		950.00				950.00	0.180
TOTAL LENGTH OF BRIDGES								60.00	0.011		
TOTAL LENGTH OF ROADWAY										5375.00	1.018
TOTAL MILES									1.029		

Figure 8-06: Preliminary Title Sheet Paper Plan

SHEET NUMBER	1
PARISH	ASCENSION
CONTROL SECTION	265-02
STATE PROJECT	H.001234
DESIGNED CHECKED	
DETAILED CHECKED	
SERIES NUMBER	1 OF 1
BY	
REVISION OR CHANGE ORDER DESCRIPTION	
DATE	
NO.	
TITLE SHEET AND LAYOUT MAP	
LA 44: INTERSECTION IMPROVEMENT @ LA 934	
ROAD DESIGN	